- Mobile

ZONING JURISDICTION:

TOWN OF STARK

SITE NUMBER:

UP30963A

SITE LOCATION:

273 BARKER ROAD MOHAWK, NY 13047 HERKIMERCOUNTY

RAN TEMPLATE: 4Sec-67E998E 6160 (LRP)


LEGAL DESCRIPTION:

UTILITY COMPANIES:


POWER: NATIONAL GRID (800) 642-4272 BACKHAUL / AAV:

VERIZON (800) 837-4966

VICINITY MAP

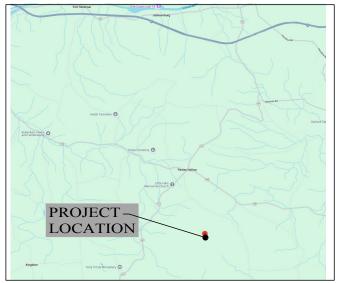

LOCATION MAP

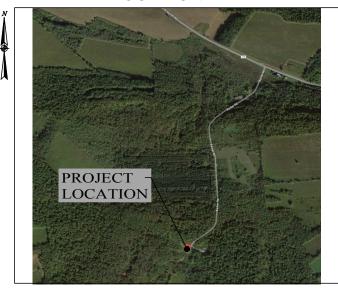

DRIVING DIRECTIONS:

From I-90 take Exit 29A to NYS Route 169. Follow NYS169 approx. 1600 feet to NYS Route 5S West. Follow NYS Route 5sWest approx. 3 miles to NYS Route 167 South and turn left. Follow NYS Route 167 approx. 5.5 miles to County Route 116 Aney Hill Road. Turn left on Aney Hill Road and follow approx. 1.3 miles to Barker Road and turn right. Barker Road terminates at the site.

APPROVED BY:	DATE:	SIGNATURE:	APPROVED BY:	DATE:	SIGNATURE:
PROJECT MANAGER			RF ENGINEER		
SITE ACQUISITION			OPERATIONS MANAGER		
ZONING			DEVELOPMENT MANAGER		
CONSTRUCTION MANAGER			REGULATORY		



PROJECT CONTACT LIST:

APPLICANT:

T-MOBILE NORTHEAST LLC 103 MONARCH DRIVE LIVERPOOL, NY 13088 (315) 453-1340

TOWER OWNER:

HARMONI TOWERS 6210 ARDREY KELL ROAD STE 450 CHARLOTTE, NC 28277 (501) 621-0521

PROJECT CONSULTANT:

CARPENTER CONSULTING GROUP 17 INDUSTRIAL STREET ROCHESTER, NY 14614 CONTACT: DON CARPENTER PHONE: (585) 370-9516

PROJECT A&E:

ALBUL ENGINEERING 3840 EAST ROBINSON ROAD AMHERST, NY 14228 CONTACT: DMITRIY ALBUL PHONE: (716) 650-8147

PROPERTY OWNER: GAGE FAMILY TRUST

5698 JERRY ROAD MARCY, NY 13403

PROJECT MANAGER:

TRANSCEND WIRELESS 1000 WYCKOFF AVENUE, 3RD FLOOR MAHWAH, NJ 07430 CONTACT: JAMIE MARCHINI PHONE: (973) 885-0660

SITE ACQUISITION & PERMITTING:

TRANSCEND WIRELESS 1000 WYCKOFF AVENUE, 3RD FLOOR MAHWAH, NJ 07430 CONTACT: JAMIE MARCHINI PHONE: (973) 885-0660

CONSTRUCTION MANAGER:

TRANSCEND WIRELESS
1000 WYCKOFF AVENUE, 3RD FLOOR
MAHWAH, NJ 07430
CONTACT: JAMIE MARCHINI
PHONE: (973) 885-0660

PROJECT INFORMATION:

CODE INFORMATION:

ZONING CLASSIFICATION: RESIDENTIAL/AGRICULTURAL BUILDING CODE: CONSTRUCTION TYPE: OCCUPANCY:

PROPOSED BUILDING USE:

SITE LOCATION: 42'56'16.9" (42.938019) -74'53'41.9" (-74.894967) 2005'± / 245'± AGL 2009'± / 249'± AGL 1760'± AMSL LATITUDE: LONGITUDE: TOP OF STRUCTURE:
TOP OF ALL APPURT.:
BASE OF STRUCTURE:

TOWN OF STARK

PROJECT LEASE AREA:

TOTAL LEASE AREA = 150 SQ. FT.

PARCEL NUMBER: 133.2-1-2.1

AREA OF PARCEL:

UNMANNED TELECOMMUNICATIONS FACILITY

NEW IMPERVIOUS AREA:

0 SQ. FT.

GENERAL INFORMATION:

PARKING REQUIREMENTS ARE UNCHANGED.

DRAWING INDEX:

SH. #:	SHEET DESCRIPTION:	REV:
T-1	TITLE SHEET	A
1-1	THEE SHEET	 ^
A-1	OVERALL SITE PLAN	A
A-2	SITE PLAN	Α
A-3	ELEVATION	Α
A-4	ANTENNA PLAN & SCHEDULE	Α
A-5	ANTENNA SPEC'S & DETAILS	Α
A-6	SITE DETAILS	Α
A-7	CABINET DETAILS	Α
A-8	GENERATOR & SITE DETAILS	Α
A-9	CABLING DETAIL & ANTENNA CONFIGURATION	A
E-1	ELECTRICAL PLAN	A
E-2	ELECTRICAL DETAILS	А
G-1	GROUNDING PLAN & DETAILS	A

PROJECT DESCRIPTION:

T-MOBILE PROPOSES PER RFDS: UP30963A-0002441095_Coverage Strategy_4Sec-67E998E_10P_Rev1_PRFDS_2024-10-10

TO MODIFY AN EXISTING UNMANNED TELECOMMUNICATIONS FACILITY WITH:

THE ADDITION OF:

- (4) RFS APXVAALL24M-U-J20 ANTENNAS
- (4) RADIO 4480 B71+B85 (4) RADIO 4460 B25+B66
- (3) SITEPRO1 VFA10-HD SECTOR FRAME 1) ENCLOSURE 6160
- (1) ENCLOSURE B160 (2) RP 6651

- (3) 6x24 70M HCS

T··Mobile

T-Mobile Northeast, LLC 103 Monarch Drive Liverpool, NY 13088 (315) 453-1340



Transcend Wireless 1000 Wyckoff Avenue, 3rd Floor Mahwah, NJ 07430





3840 E. ROBINSON ROAD AMHERST, NY 14228 WWW.ALBULENG.COM C.A.#PB 106682

ı	ENGINEERING SEAL:
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PEVISIONS:			
DESCRIPTION	DATE	BY	REV
ISSUED FOR REVIEW	11/29/24	DWC	A
		DESCRIPTION DATE	DESCRIPTION DATE BY

MURRAY HILL


UP30963A

273 BARKER ROAD MOHAWK, NY 13047


TITLE SHEET

SHEET NUMBER: -

T-1

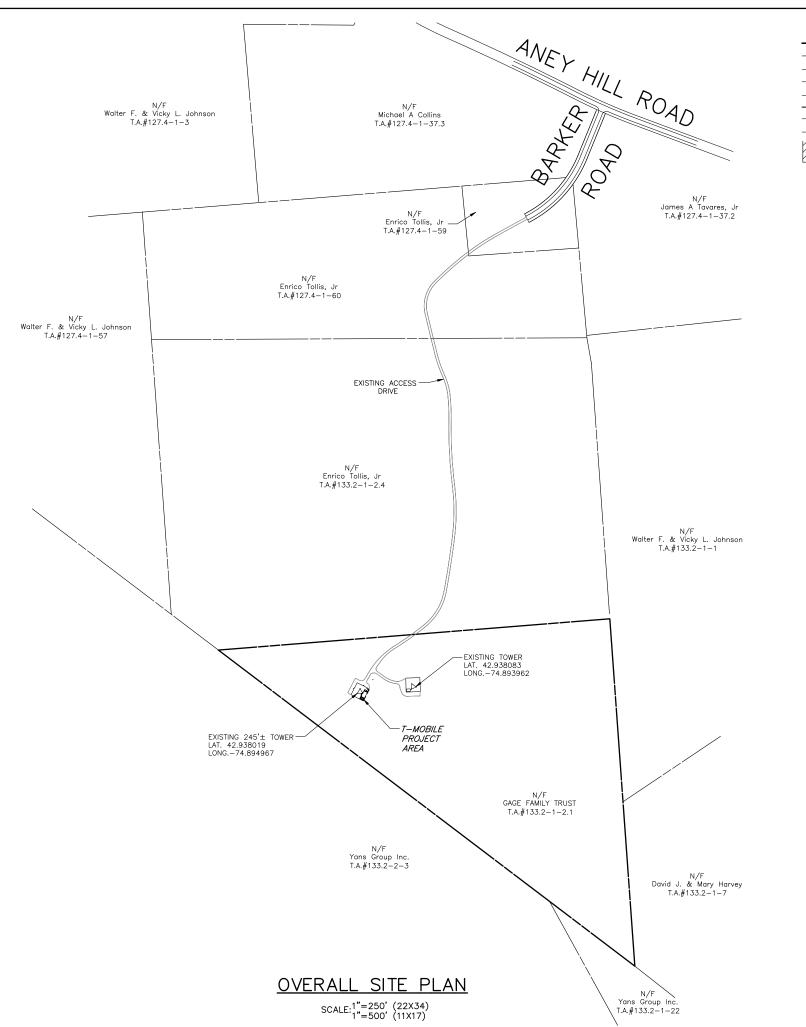



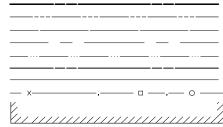

SECTION/PARCEL BOUNDARY
PROPOSED EASEMENT LINE
MIN. BUILDING SETBACK
CENTER LINE
EXIST. EASEMENT LINE
EXIST. RIGHT-OF-WAY LINE
EXIST. EDGE OF PAVEMENT
BARBED WIRE,STOCKADE,CHAIN LINK
EXISTING BUILDING



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REVISIONS:			
DESCRIPTION	DATE	BY	REV.
ISSUED FOR REVIEW	11/29/24	DWC	A

SITE NAME:

MURRAY HILL

—SITE NUMBER


UP30963A

SITE ADDRES

273 BARKER ROAD MOHAWK, NY 13047

OVERALL SITE PLAN

SHEET NUMBE

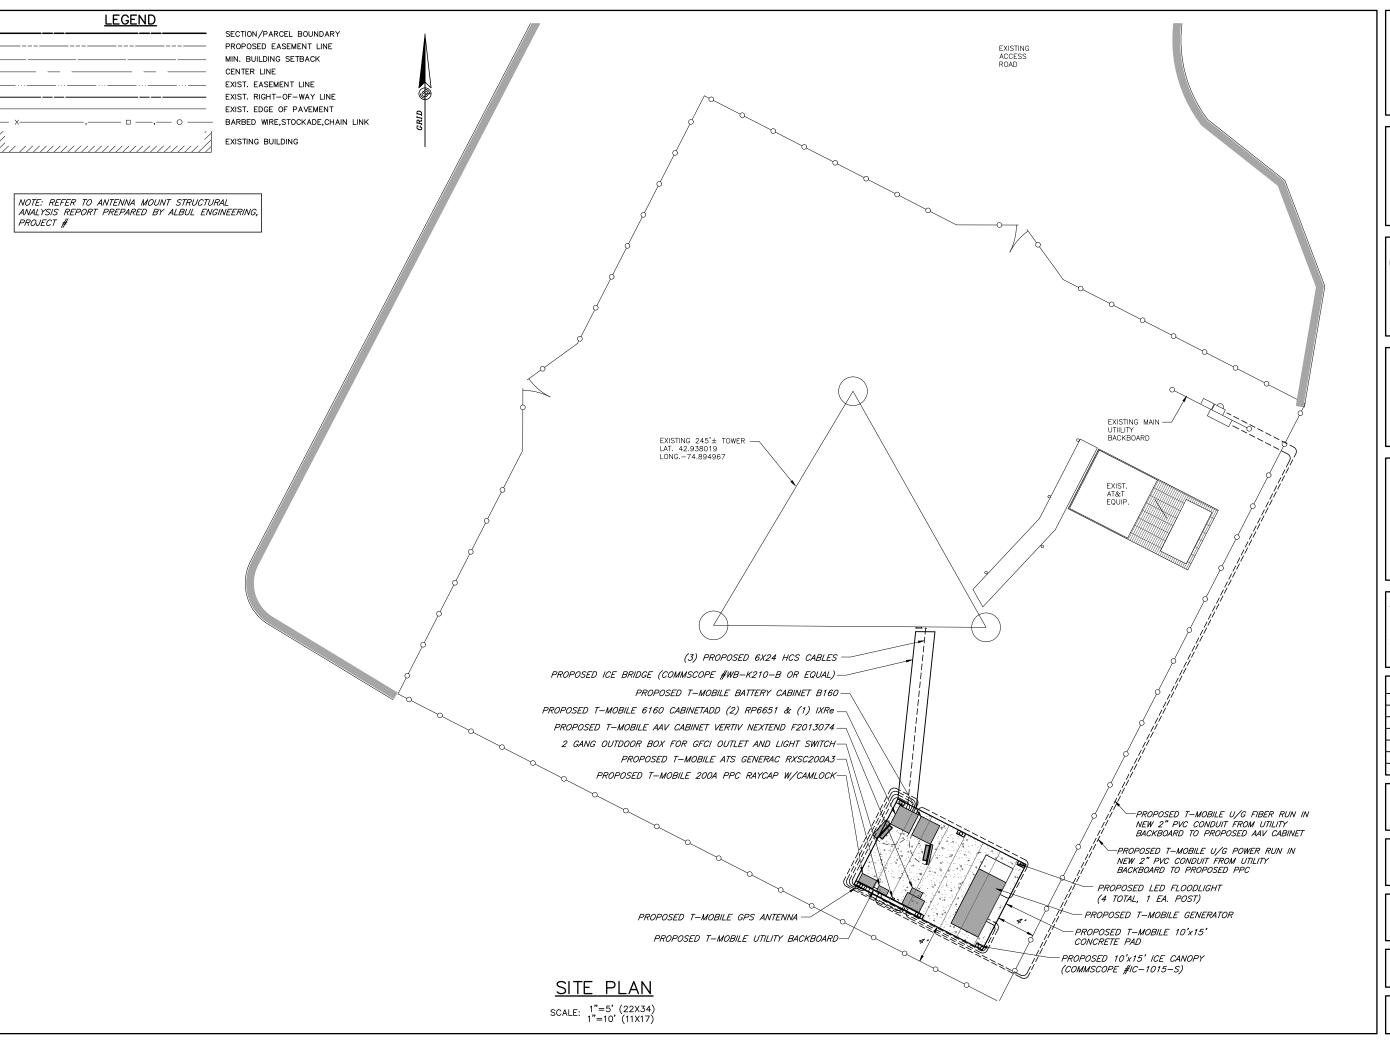

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Transcend Wireless 1000 Wyckoff Avenue, 3rd Floor Mahwah, NJ 07430



DEVELOPMENT DESIGN
RESIDENTIAL | COMMERCIAL | WIRELESS | ENERGY
17 INDUSTRIAL STREET | ROCHESTER, W14614
Office: 585-360-2733 | Fax: 585-360-2735



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ENGINEERING SEAL:

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REVISIONS:			
DESCRIPTION	DATE	BY	REV.
ISSUED FOR REVIEW	11/29/24	DWC	A

SITE NAME:

MURRAY HILL

-SITE NUMBER: -

UP30963A


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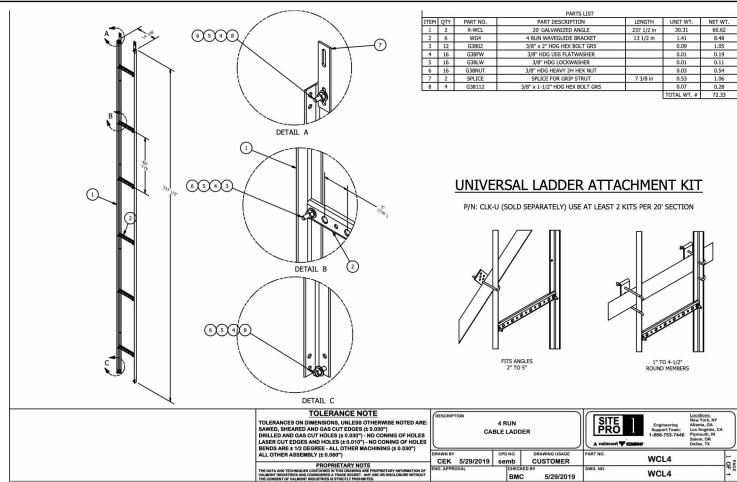
273 BARKER ROAD MOHAWK, NY 13047

-SHEET DESCRIPTION


SITE PLAN

SHEET NUMBER:



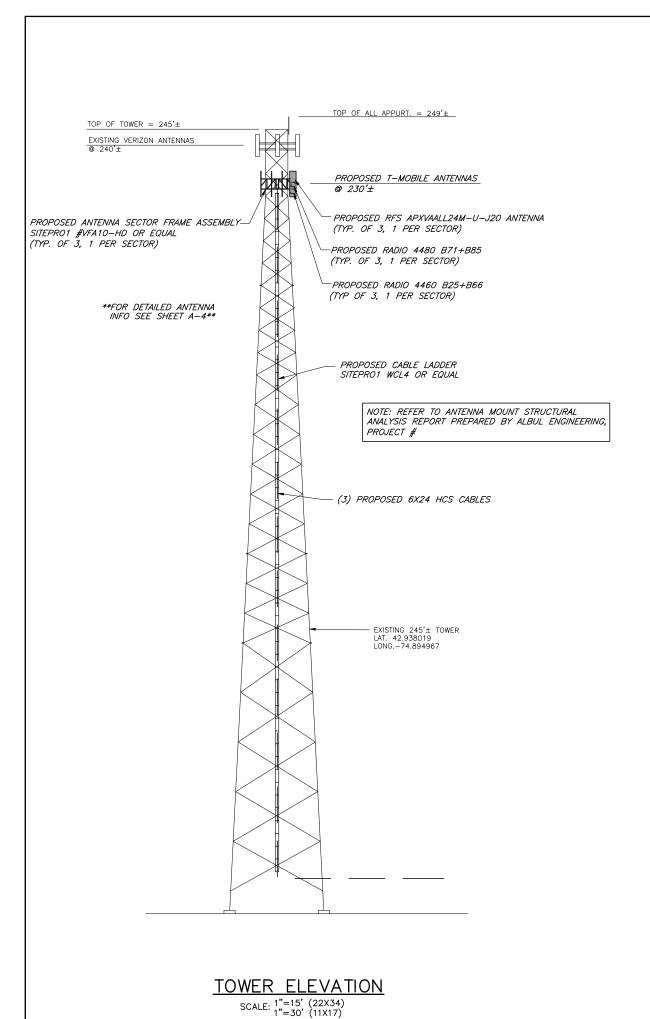

CABLE LADDER

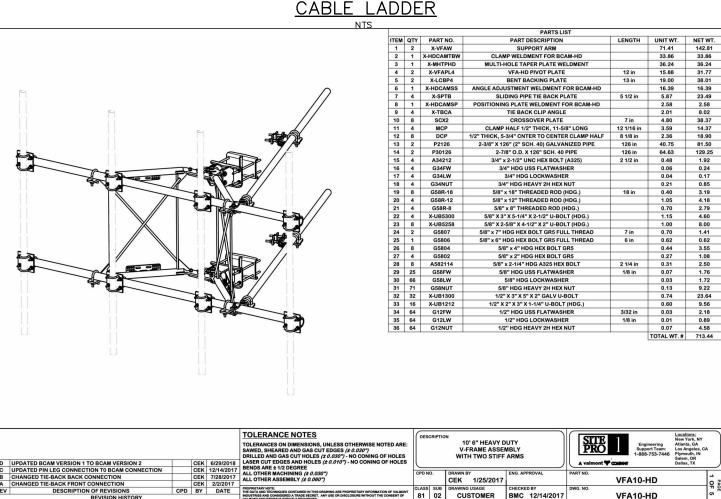

ANTENNA SECTOR FRAME ASSEMBLY

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DEVELOPMENT DESIGN



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REVISIONS:			
DESCRIPTION	DATE	BY	REV.
ISSUED FOR REVIEW	11/29/24	DWC	A

MURRAY HILL

UP30963A

273 BARKER ROAD MOHAWK, NY 13047

ELEVATION

SHEET NUMBER: •

<u>LEGEND</u>	
	SECTION/PARCEL BOUNDARY
	PROPOSED EASEMENT LINE
	MIN. BUILDING SETBACK
	CENTER LINE
	EXIST. EASEMENT LINE
	EXIST. RIGHT-OF-WAY LINE
	EXIST. EDGE OF PAVEMENT
— x———,—— □ ——,— ○ ——	BARBED WIRE, STOCKADE, CHAIN LIN
	EXISTING BUILDING



NOTE: REFER TO ANTENNA MOUNT STRUCTURAL ANALYSIS REPORT PREPARED BY ALBUL ENGINEERING,

PHA SECTOR AZIMUTH O'
AZ AZ

				ANTENNA	SCH	DULE			
SECTOR	STATUS	ANTENNA MANUFACTURER	ANTENNA MODEL	ANTENNA DIMENSIONS (HxWxD)	RAD CENTER	AZIMUTH	RRU QUANTITY & MODEL	CABLE QUANTITY & TYPE	CABLE LENGTH
A1	PROPOSED	RFS	APXVAALL24M-U-J20	95.9"x19.7"x8.5"	230'±	0,	(1) ERICSSON RADIO 4480 (1) ERICSSON RADIO 4460	(1) 6X24 HCS CABLE	70 METER
A2	EMPTY						(1) ERICSSON RADIO 4400		
A3	EMPTY								
B1	PROPOSED	RFS	APXVAALL24M-U-J20	95.9"x19.7"x8.5"	230'±	90°	(1) ERICSSON RADIO 4480 (1) ERICSSON RADIO 4460	(1) 6X24 HCS CABLE	70 METER
G1	PROPOSED	RFS	APXVAALL24M-U-J20	95.9"x19.7"x8.5"	230'±	180*	(1) ERICSSON RADIO 4480	(1) 6X24 HCS CABLE	70 METER
G2	EMPTY						(1) ERICSSON RADIO 4460		
G3	EMPTY								
G4	EMPTY								
D1	PROPOSED	RFS	APXVAALL24M-U-J20	95.9"x19.7"x8.5"	230'±	270°	(1) ERICSSON RADIO 4480		
D2	EMPTY						(1) ERICSSON RADIO 4460		
D3	EMPTY								
D4	EMPTY						1		

NOTES:
1. CONTRACTOR TO VERIFY PROPOSED ANTENNA INFORMATION IS THE MOST CURRENT DATA AT TIME OF CONSTRUCTION.
2. CONTRACTOR TO CONFIRM CABLE LENGTHS PRIOR TO CONSTRUCTION.

PROPOSED RFS APXVAALL24M-U-J20 ANTENNA -(TYP. OF 4, 1 PER SECTOR) BETA SECTOR AZIMUTH 90* PROPOSED RADIO 4480 B71+B85 (TYP. OF 4, 1 PER SECTOR) PROPOSED RADIO 4460 B25+B66-(TYP OF 4, 1 PER SECTOR) D3 G3 GAMMA SECTOR AZIMUTH 130" PROPOSED ANTENNA SECTOR FRAME ASSEMBLY -SITEPRO1 #VFA10—HD OR EQUAL (TYP. OF 3, 1 PER SECTOR)

PROPOSED ANTENNA PLAN

SCALE: 1"=2' (22X34) 1"=4' (11X17)

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П	ENGINEERING SEAL:		
П			

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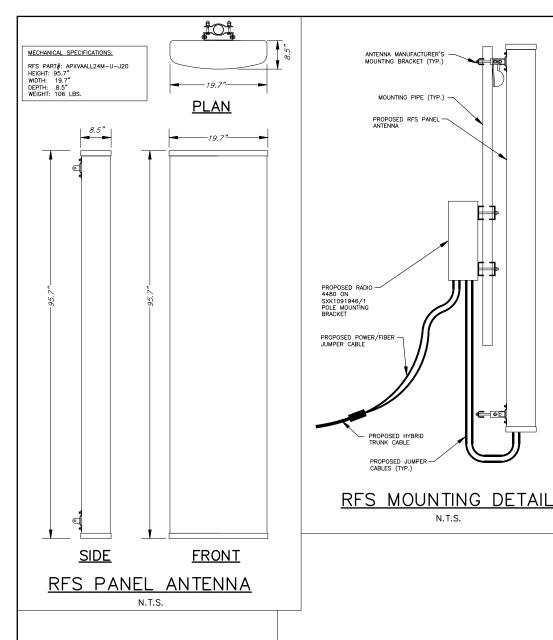
MURRAY HILL


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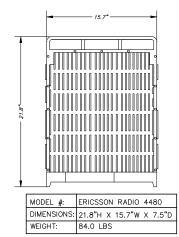
ANTENNA PLAN & SCHEDULE

-SHEET NUMBER: -






SXK1091946/1 SIDE MOUNT DETAIL N.T.S.

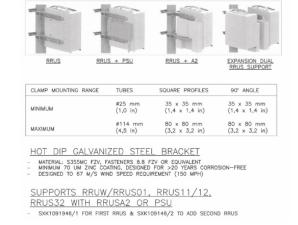


RADIO 4480 DETAIL

N.T.S.

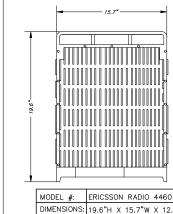

RADIO 4460 DETAIL

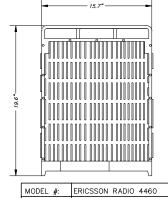



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DESCRIPTION	П	DATE	BY	REV.
ISSUED FOR REVIEW		11/29/24	DWC	A

MURRAY HILL


UP30963A

273 BARKER ROAD MOHAWK, NY 13047

SHEET DESCRIPTION: -

ANTENNA SPEC'S & DETAILS

A-5

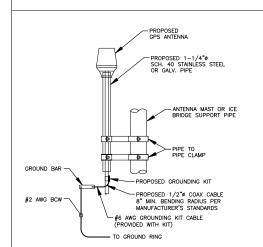

GPS MOUNTING DETAIL

3. IT IS CRITICAL THAT THE GPS ANTENNA IS MOUNTED SUCH THAT IT IS WITHIN 2 DEGREES OF VERTICAL & THE BASE OF THE ANTENNA IS WITHIN 2 DEGREES OF LEVEL. 4. DO NOT SWEEP TEST GPS ANTENNA.

MINIMUM OF 75% OR 270° IN ANY DIRECTION


NOTES:

GPS MINIMUM SKY


VIEW REQUIREMENTS

SPALL BE IN ACCORDANCE WITH THE FINAL RY REPORT.

2. THE GPS ANTENNA MOUNT IS DESIGNED TO FASTEN TO A STANDARD 1-1/4" DIAMETER, SCHEDULE 40, GALWANIZED STEEL OR STANLESS STEEL PRE: THE PIPE MUST NOT BE THEREOED AT THE ANTENNA MOUNT END THE PIPE-SHALL BE STORT TO THE ANTENNA MOUNT END THE PIPE-SHALL BE STORT TO THE ANTENNA MOUNT END THE CHARLESS TO THE CHARLESS AND THE CHARLESS

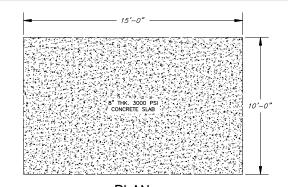

<u>PLAN</u>

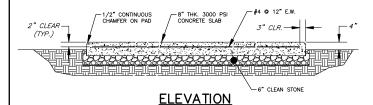

EQUIPMENT CONCRETE PAD DETAIL

ITEM PART NO.

3 IC101501 4 IC101502

8 MT-387 9 GWL-03

10 GN-03 11 GUB-4355 12 GUB-4456 13 MT-379-6

14 GWF-04 15 GWL-04

16 GN-04

MF126.01 MT-287

GJB0380

1 WB-CY210 2 WB-CY110

DESCRIPTION

SAFETY GRATING 24" X 10"

SAFETY GRATING 12" X 10'

15' ICE SHIELD SUPPORT BRACKET Diagonal Support

BASE SHOE

3/4" x 7" WEDGE ANCHOR

8" GALV J-BOLT KIT

SQUARE WASHER, 1-1/2" X 1-1/2" W/ 7/16" HOLE 3/8" GALV LOCK WASHER

3/8" GALV HEX NUT
1/2" X 3-5/8" X 5" GALV U-BOLT
1/2" X 4-5/8" X 6-1/2" GALV U-BOLT
1/2" X 6" GALV THREADED ROD

1/2" GALV FLAT WASHER


1/2" GALV LOCK WASHER

1/2" GALV HEX NUT

15'-0" [4572]

NOTES:
1. ALL METRIC DIMENSIONS ARE IN BRACKETS.

86.75 [2203.5]

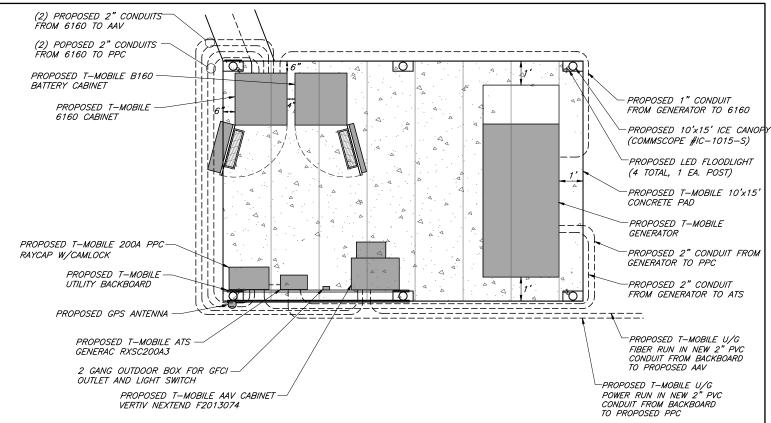

GROUND EQUIPMENT LAYOUT

SCALE: 1"=2' (22X34) 1"=4' (11X17)

(3)

IC-1015-S

COMMSCOPE

10'-9 5/8" [3292.5]

MSM

Α

08/23/12 A36, A53, A568

VERTIV™ NUMBER	DESCRIPTION
F2013074	Outdoor Solution w/DC Power
Equipped with	the following:
1EA	NetXtend Compact with heat exchanger, NXC2416AAV1H05BB3 and slide-out shelf
1EA	NetSure 211 power system
2 EA	500 W rectifiers
1EA	19" rack-mount, slide-out tray
1EA	AC outlet mounting bracket
2 EA	20 A, 120 VAC outlets
1EA	Wall-mounting kit

Technical Specifications

ELECTRICAL			
System Voltage	120 VAC single phase (nominal)		
Output Voltage	-42 VDC to -58 VDC		
System Capacity	19" 1 RU up to 8 A		
Rectifier Capacity	0.4 kW @ 120 VAC		
DC Distribution	Wallmount GMT fuse panel with (10) fuses, up to 15 A		
Controller	SCU+ controller		
PHYSICAL CHARACTERISTICS			

Up to 14 RU, 19" W

Enclosure: 24" x 24" x 16" Battery tray: 22" W x 13" D Wall or H-frame, pole mount (wall-mount kit included) Enclosure: 64 lb., w/out batteries Four (4) batteries: 36 lb. total



AAV CABINET DETAIL

T··Mobile

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Transcend Wireless 1000 Wyckoff Avenue, 3rd Floor Mahwah, NJ 07430





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MURRAY HILL

UP30963A

273 BARKER ROAD MOHAWK, NY 13047

SITE DETAILS

A-6



113.88 [2892.4]

76.00 LBS 70.00 LBS

97.47 LBS 56.31 LBS

69.59 LBS


0.23 LBS

0.11 LBS 0.00 LBS

0.04 LBS 1.27 LBS 1.27 LBS 0.33 LBS


0.06 LBS 0.00 LBS

4 0.04 LBS

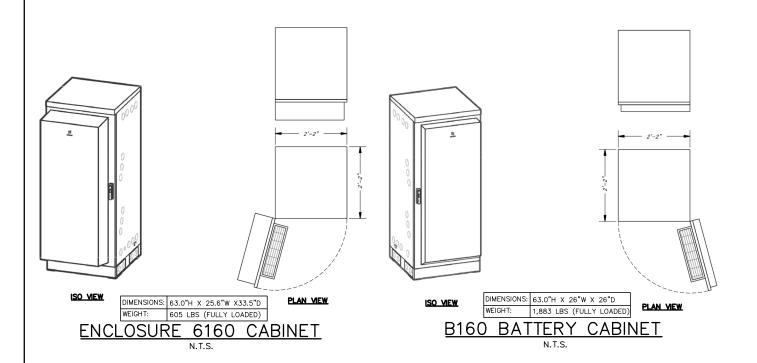


Right of the cabinet

0.000

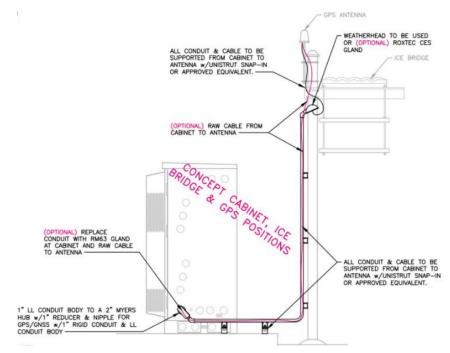

GPS CABLE ROUTING DETAIL

NOTE:
(LIQUIDFLEX) FLEXIBLE METALLIC CONDUIT (LFMC)
& ASSOCIATED FITTINGS CAN BE USED AS NEEDED
BUT ONLY FOR TIGHT CONDUIT BENDS AND RUNS
SUBJECT TO UL AND NEC LIMITATIONS. 6' MAX
PER CONDUIT RUN

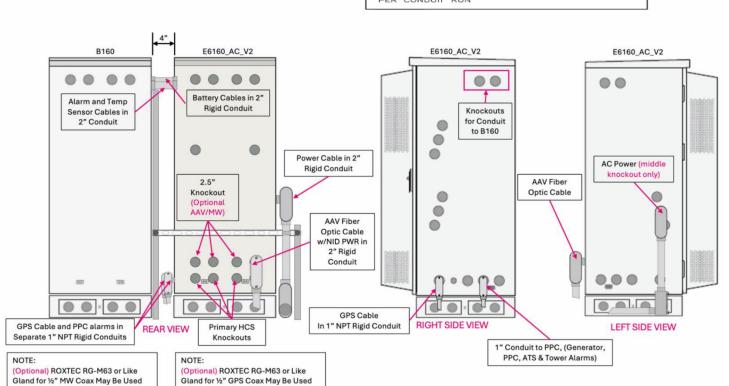

STANDARD CABINET CONFIGURATION

N.T.S.



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DESCRIPTION	DATE	BY	REV.
ISSUED FOR REVIEW	11/29/24	DWC	A

SITE NAME: -

MURRAY HILL

TE NUMBER:

UP30963A

SITE ADDRESS:


273 BARKER ROAD MOHAWK, NY 13047

SHEET DESCRIPTION: -

CABINET DETAILS

—SHEET NUMBER

A-7

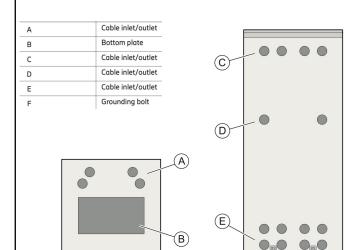

Bottom of the cabinet

GNSS connection point

Grounding bolt
Grounding bolt
Cable inlet/outlet

Cable inlet/outle

Cable inlet/outlet

Cable inlet/outlet

Cable inlet/outlet

Cable inlet/outlet

....

(G)-

(D)

1.ALL CONDUIT AND FITTING ENTRANCES INTO CABINETS AND ENCLOSURES MUST UTILIZE MYERS OR EQUIVALENT HUBS OR SEALING WASHERS TO PREVENT WATER ENTRY/SEEPAGE INTO CABINETS AND ENCLOSURES.

Left of the cabinet

000

2.LIQUIDFLEX FLEXIBLE METTALIC METAL CONDUIT (LFMC) & ASSOCIATED FITTINGS CAN BE USED AS NEEDED BUT ONLY FOR TIGHT CONDUIT BENDS AND RUNS SUBJECT TO UL / NEC LIMITATIONS. 6' MAX PER CONDUIT RUN.

3.POWER CONDUIT BODY ATTACHED WITH SHORT NIPPLE AND SEALING WASHER INSIDE AND OUT (FOR DOOR HOOD CLEARANCE).

4.PULLING ELBOWS MAY BE USED IN LIEU OF CONDUIT BODIES WHEN CLEARANCE IS LIMITED.


5.ALL EXTERNAL ALARM CONDUITS ARE TO TERMINATE AT THE PPC WITH A SINGLE 1" ALARM CONDUIT TO THE 6160.


6.CONDUIT SHOULD HAVE SEALING WASHERS INSIDE AND OUT WITH LOCK NUT AND CAP. DO NOT USE4 CHASE NIPPLES.

6160 ENCLOSURE DETAIL

N.T.S

Back of the cabinet

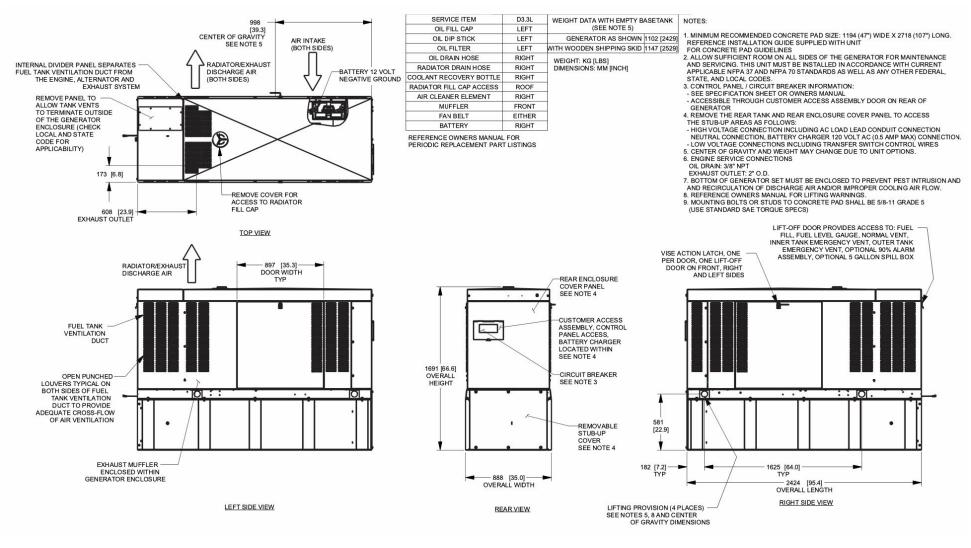

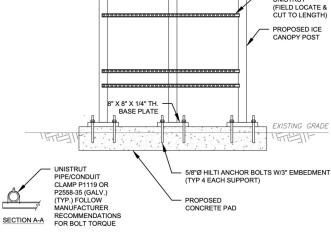

3'-7"


H-FRAME NOTES:

- IF IT IS NECESSARY TO EXTEND THE H-FRAME, AN ADDITIONAL POST WILL ALWAYS BE REQUIRED.
- PROPOSED UNISTRUTS TO BE FIELD CUT AND SHOULD NOT EXTEND MORE THAN 6 INCHES BEYOND THE LAST POST.
- S. SPRAY ENDS OF UNISTRUT WITH COLD GALVANIZING SPRAY PAINT, ALLOW TO DRY,
 THEN COVER WITH BURBER PROTECTIVE CAPS FOR SAFETY
- 4. UNISTRUT TO BE CUT FLUSH WITH NO SHARP OR JAGGED EDGES.
- 5. ALL PROPOSED HARDWARE TO BE MOUNTED PER MANUFACTURERS SPECS.

PROPOSED BACKBOARD DETAIL

1.T.S.

Model		RXSW200A3
Height - in (mm)		26.8 (679.4)
		30.0 (672.0)
1	W1	10.5 (266.7)
Width - in (mm) W2		13.5 (342.9)
Depth - in (mm)		6.3 (160.1)
Weight - Ibs (kg)		39.0 (17.7)

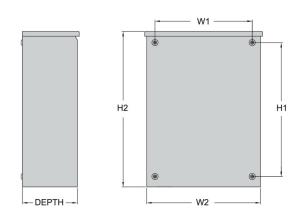

GENERAC AUTOMATIC TRANSFER SWITCH (RXSC200A3)

N.T.S.

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3"Ø SCH.40 PIPE (GA

1-5/8" X 10'-0"



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SITE NAME:

MURRAY HILL

—SITE NUMBER

UP30963A

SITE ADDRES

273 BARKER ROAD MOHAWK, NY 13047

SHEET DESCRIPTI


GENERATOR & SITE DETAILS

SHEET NUMBER

A-8

GENERAC 48kW DIESEL GENERATOR (RD048)


N.T.S.

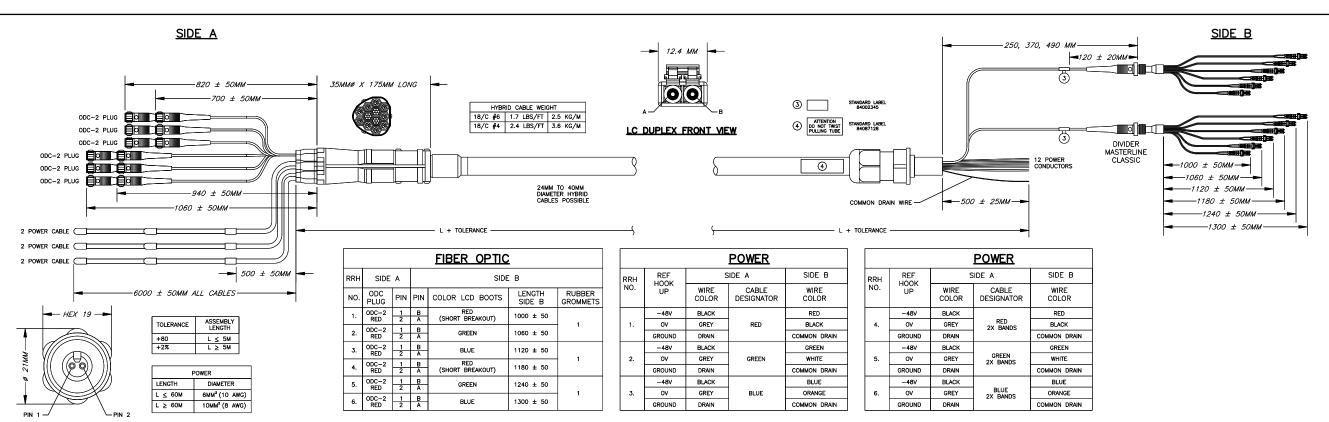

MLE HYBRID CABLE (6 POWER/24 FIBER)

ODC-2 PLUG FRONT VIEW

N.T.S.

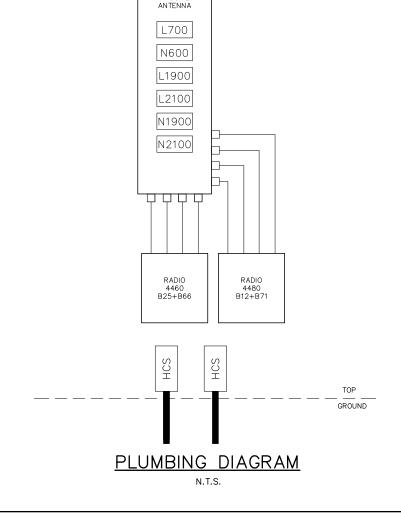

PASSIVE

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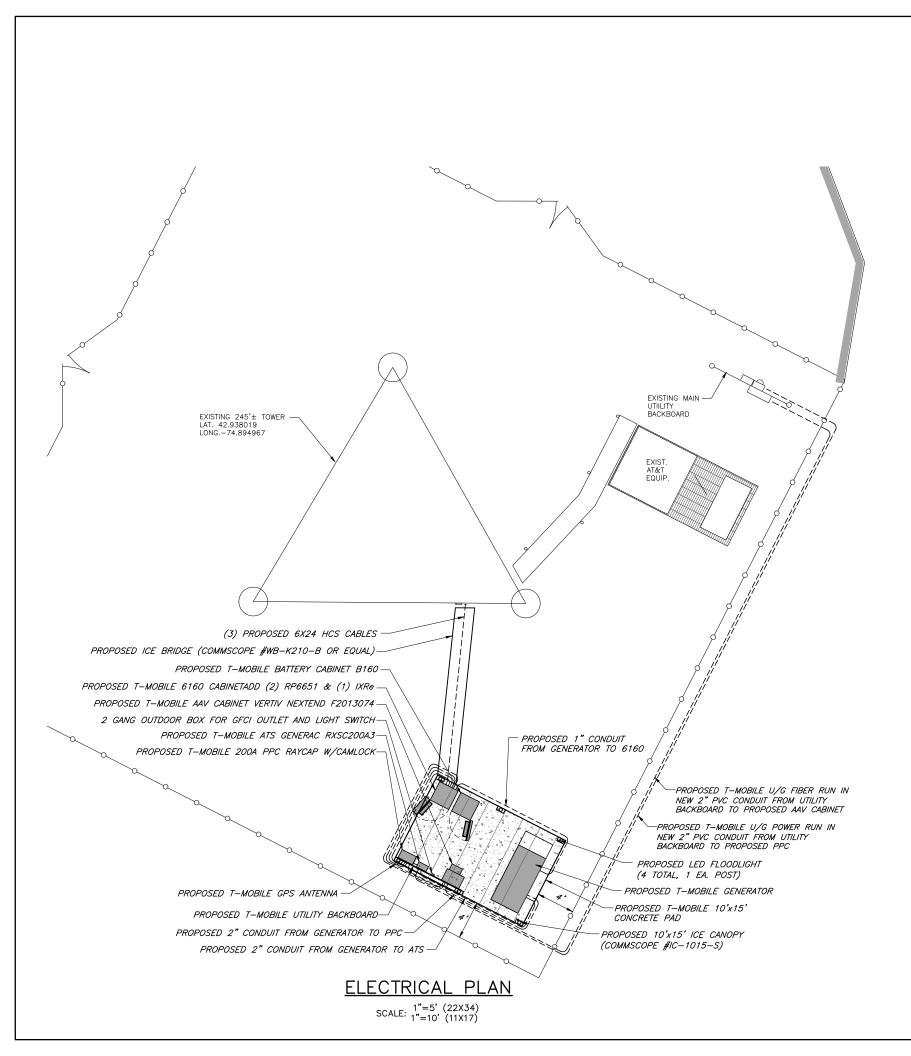
SITE ADDRESS

273 BARKER ROAD MOHAWK, NY 13047

-SHEET DESCRIPTION:

CABLING DETAIL & ANTENNA CONFIGURATION

SHEET NUMBER:





SECTION/PARCEL BOUNDARY
PROPOSED EASEMENT LINE
MIN. BUILDING SETBACK
CENTER LINE
EXIST. EASEMENT LINE
EXIST. RIGHT-OF-WAY LINE
EXIST. EDGE OF PAVEMENT
BARBED WIRE,STOCKADE,CHAIN LINK

EXISTING BUILDING

ELECTRICAL NOTES

 SUBMITTAL OF BID INDICATES THAT THE CONTRACTOR IS COGNIZANT OF ALL JOB SITE CONDITIONS AND WORK TO BE PERFORMED UNDER THIS CONTRACT.

LEGEND

- 2. CONTRACTOR SHALL PERFORM ALL VERIFICATIONS, OBSERVATION TESTS, AND EXAMINATION WORK PRIOR TO ORDERING OF ANY EQUIPMENT AND THE ACTUAL CONSTRUCTION. CONTRACTOR SHALL ISSUE A WRITTEN NOTICE OF ALL FINDINGS TO THE PROJECT MANAGER LISTING ALL MALFUNCTIONS, FAULTY EQUIPMENT AND DISCREPANCIES.
- 3. VERIFY HEIGHTS WITH PROJECT MANAGER PRIOR TO INSTALLATION.
- 4. THESE PLANS ARE DIAGRAMMATIC ONLY, FOLLOW AS CLOSELY AS POSSIBLE.
- CONTRACTOR SHALL COORDINATE ALL WORK BETWEEN TRADES AND ALL OTHER SCHEDULING AND PROVISIONARY CIRCUMSTANCES SURROUNDING THE PROJECT.
- CONTRACTOR SHALL PROVIDE ALL LABOR, MATERIALS, INSURANCE, EQUIPMENT, INSTALLATION CONSTRUCTION TOOLS, TRANSPORTATION, ETC., FOR COMPLETE AND FUNCTIONALLY OPERATING SYSTEMS ENERGIZED AND READY FOR USE THROUGHOUT AS INDICATED ON DRAWINGS. AS SPECIFIED HEREIN AND/OR AS OTHERWISE REQUIRED.
- 7. ALL MATERIALS AND EQUIPMENT SHALL BE NEW AND IN PERFECT CONDITION WHEN INSTALLED AND SHALL BE OF THE BEST GRADE AND OF THE SAME MANUFACTURER THROUGHOUT FOR EACH CLASS OR GROUP OF EQUIPMENT. ELECTRICAL MATERIALS SHALL BE LISTED AND APPROVED BY UNDERWRITER'S LABORATORIES AND SHALL BEAR THE INSPECTION LABEL "J" WHERE SUBJECT TO SUCH APPROVAL. MATERIALS SHALL MEET WITH APPROVAL OF ALL GOVERNING BODIES HAVING JURISDICTION OVER THE CONSTRUCTION. MATERIALS SHALL BE MANUFACTURED IN ACCORDANCE WITH ALL CURRENT APPLICABLE STANDARDS ESTABLISHED BY ANSI, NEMA AND NBFU. ALL MATERIALS AND EQUIPMENT SHALL BE APPROVED FOR THEIR INTENDED USE AND LOCATION.
- 8. ALL WORK SHALL COMPLY WITH ALL APPLICABLE GOVERNING STATE, COUNTY AND CITY CODES AND OSHA, NFPA, NEC & ASHRAE REQUIREMENTS.
- ENTIRE JOB SHALL BE GUARANTEED FOR A PERIOD OF ONE (1) YEAR AFTER THE DATE OF JOB ACCEPTANCE. ALL WORK, MATERIAL AND EQUIPMENT FOUND TO BE FAULTY DURING THAT PERIOD SHALL BE CORRECTED AT ONCE, UPON WRITTEN NOTIFICATION, AT THE EXPENSE OF THE CONTRACTOR.
- 10. PROPERLY SEAL ALL PENETRATIONS. PROVIDE UL LISTED FIRE-STOPS WHERE PENETRATIONS ARE MADE THROUGH FIRE-RATED ASSEMBLIES. WATER-TIGHT USING SILICONE SEALANT.
- 11. LOCATE ALL PENETRATIONS SUCH THAT ALL REINFORCEMENT CONTAINED WITHIN THE EXISTING BUILDING CONSTRUCTION REMAINS INTACT AND UNDISTURBED. SUBMIT LOCATING METHOD TO THE PROJECT MANAGER FOR APPROVAL PRIOR TO EXECUTION.
- 12. DELIVER ALL BROCHURES, OPERATING MANUALS, CATALOGS AND SHOP DRAWINGS TO THE PROJECT MANAGER AT JOB COMPLETION. PROVIDE MAINTENANCE MANUALS FOR MECHANICAL EQUIPMENT. AFFIX MAINTENANCE LABELS TO MECHANICAL EQUIPMENT.
- 13. ALL CONDUCTORS SHALL BE COPPER. MINIMUM CONDUCTOR SIZE SHALL BE #12 AWG., UNLESS OTHERWISE NOTED. CONDUCTORS SHALL BE TYPE THHW, RATED IN ACCORDANCE WITH NEC 110-14(C).
- 14. ALL CIRCUIT BREAKERS, FUSES AND ELECTRICAL EQUIPMENT SHALL HAVE AN INTERRUPTING RATING NOT LESS THE MAXIMUM INTERRUPTING CURRENT TO WHICH THEY MAY BE SUBJECTED.
- 15. THE ENTIRE ELECTRICAL INSTALLATION SHALL BE GROUNDED IN ACCORDANCE WITH THE NATIONAL ELECTRICAL CODE; ARTICLES 250 & 810 AND THE UTILITY COMPANY STANDARDS.
- 16. CONDUIT:
- A. RIGID CONDUIT SHALL BE U.L. LABEL GALVANIZED ZINC COATED WITH ZINC INTERIOR AND SHALL BE USED WHEN INSTALLED IN OR UNDER CONCRETE SLABS, IN CONTACT WITH THE EARTH, UNDER PUBLIC ROADWAYS, IN MASONRY WALLS OR EXPOSED ON BUILDING EXTERIOR. RIGID CONDUIT IN CONTACT WITH EARTH SHALL BE 1/2 LAPPED WEADLED WITH LINES WEAD PROCESS NO. 3
- B. ELECTRICAL METALLIC TUBING SHALL HAVE U.L. LABEL, FITTINGS SHALL BE GLAND RING COMPRESSION TYPE, EMT SHALL BE USED ONLY FOR INTERIOR RUNS.
- C. LIQUID-TIGHT FLEXIBLE METAL CONDUIT SHALL BE U.L. LISTED AND SHALL BE USED AT FINAL CONNECTIONS TO MECHANICAL EQUIPMENT & RECTIFIERS AND WHERE PERMITTED BY CODE, ALL CONDUIT IN EXCESS OF SIX FEET IN LENGTH SHALL CONTAIN A FULL-SIZE GROUND CONDUCTOR.
- D. CONDUIT RUNS SHALL BE SURFACE MOUNTED ON CEILINGS OR WALLS UNLESS NOTED OTHERWISE. ALL CONDUIT SHALL RUN PARALLEL OR PERPENDICULAR TO WALLS, FLOOR, CEILING, OR BEAMS. VERIFY EXACT ROUTING OF ALL EXPOSED CONDUIT WITH THE PROJECT MANAGER PRIOR TO INSTALLING.
- E. PVC CONDUIT MAY BE PROVIDED ONLY WHERE SHOWN, OR IN UNDERGROUND INSTALLATIONS. PROVIDE UV—RESISTANT CONDUIT WHERE EXPOSED TO THE ATMOSPHERE. PROVIDE GROUND CONDUCTOR IN ALL PVC RUNS; EXCEPT WHERE PERMITTED BY CODE TO OMIT.
- 17. ALL ELECTRICAL EQUIPMENT SHALL BE LABELED WITH PERMANENT ENGRAVED PLASTIC LABELS. BACKGROUND SHALL BE BLACK WITH WHITE LETTERS; EXCEPT AS REQUIRED BY CODE TO FOLLOW A DIFFERENT SCHEME.
- 18. UPON COMPLETION OF WORK, CONDUCT CONTINUITY, SHORT CIRCUIT, AND FALL OF POTENTIAL GROUNDING TESTS FOR APPROVAL SUBMIT TEST REPORTS TO PROJECT MANAGER, GROUNDING SYSTEM RESISTANCE SHALL NOT EXCEED 5 OHMS. IF THE RESISTANCE VALUE IS EXCEEDED, NOTIFY THE PROJECT MANAGER FOR FURTHER INSTRUCTION ON METHODS FOR REDUCING THE RESISTANCE VALUE.
- 19. CLEAN PREMISES OF ALL DEBRIS RESULTING FROM WORK AND LEAVE WORK IN A COMPLETE AND UNDAMAGED CONDITION, LEGALLY DISPOSE OF ALL REMOVED, UNUSED AND EXCESS MATERIAL GENERATED BY THE WORK OF THIS CONTRACT, DELIVER ITEMS INDICATED ON THE DRAWINGS TO THE OWNER IN GOOD CONDITION. OBTAIN SIGNED RECEIPT UPON DELIVERY.
- 20. COORDINATE WITH UTILITY COMPANY FOR CONNECTION OF TEMPORARY AND PERMANENT POWER TO THE SITE, THE TEMPORARY POWER AND ALL HOOKUP COSTS SHALL BE PAID BY THE CONTRACTOR.
- 21. VERIFY ALL EXISTING CIRCUITRY PRIOR TO REMOVAL AND NEW WORK. MAINTAIN POWER TO ALL OTHER AREAS & CIRCUITS NOT SCHEDULED FOR REMOVAL.
- 22. RED LINED AS-BUILT PLANS SHALL BE PROVIDED TO THE CONSTRUCTION MANAGER.

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ISSUED FOR REVIEW	11/29/24	DWC	A

SITE NAME:

MURRAY HILL

SITE NUMBER:

UP30963A

SITE ADDRESS:


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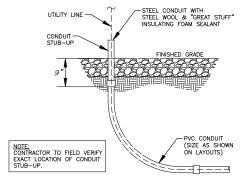
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ELECTRICAL PLAN


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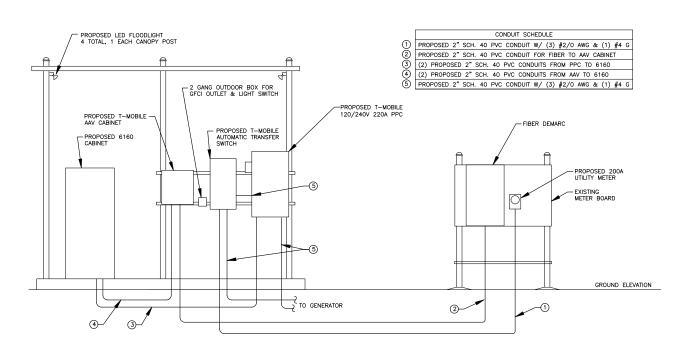
CONDUIT STUB-UP DETAIL



UTILITY TRENCH DETAIL

N.T.S.

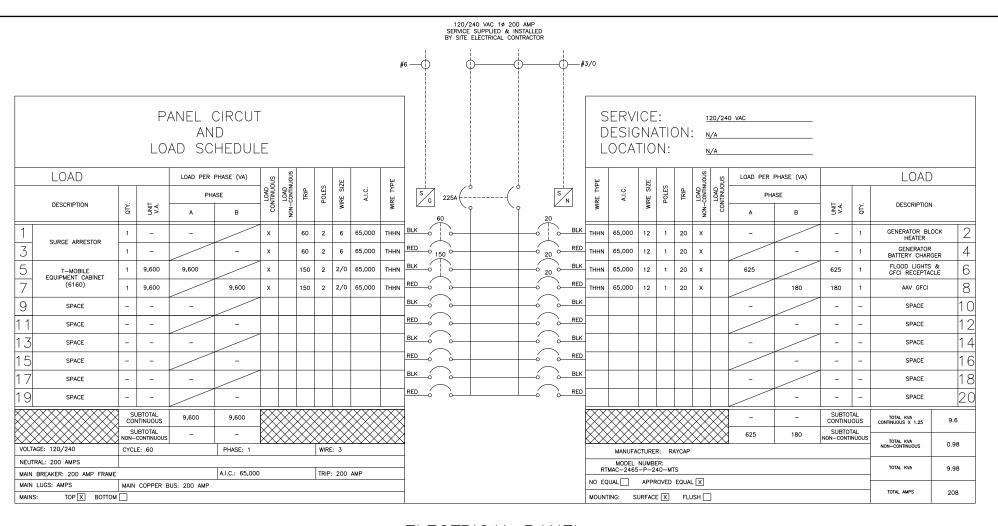ELECTRICAL PANEL

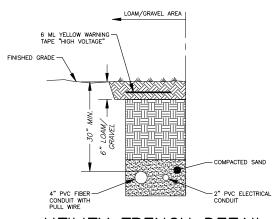

POWER DIAGRAM

Power Protection Cabinet

RTMAC-2465-P-240-MTS



Mechanical			
Deadfront	Hinged		
Operating Temperature (°C)	-40° C to +75° C		
Enclosure Type (Outdoor)	3R Powder Coated Aluminum		
Enclosure Dimension (H×W×D)	39" × 22.855" × 12.593"		
Generator receptacle standard mounting	Right		
Weight	80 lbs.		

RAYCAP PPC W/CAMLOCK

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MURRAY HILL


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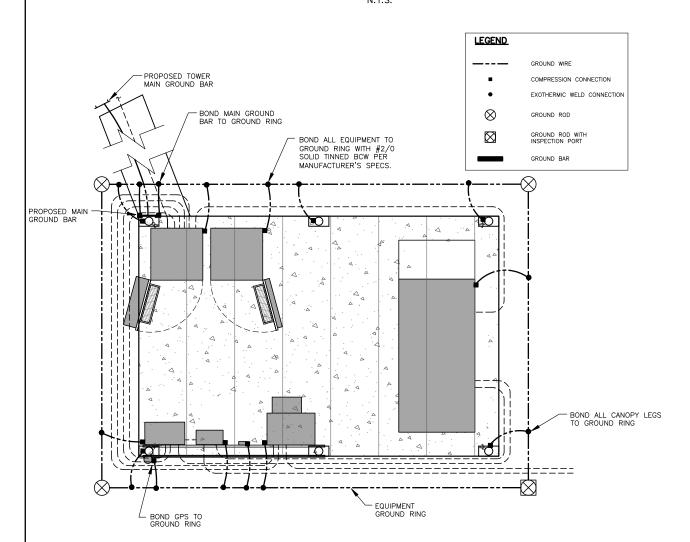
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ELECTRICAL DETAILS

-SHEET NUMBER: -

E-2



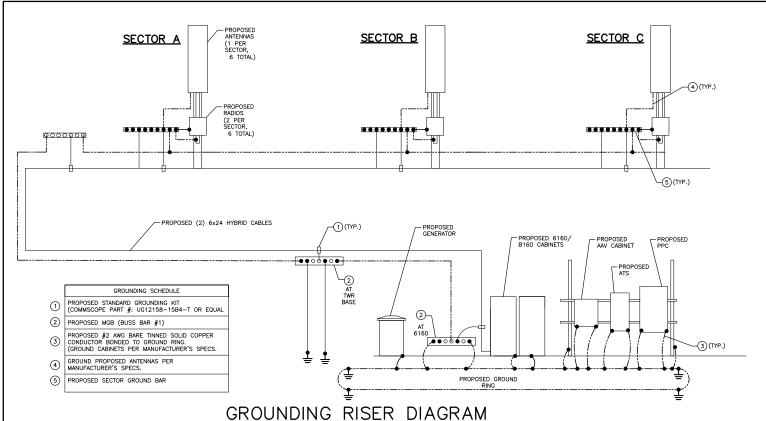


GROUNDING PLAN N.T.S.

GROUNDING NOTES:

- 1. GROUNDING SHALL COMPLY WITH ARTICLE 250 OF THE NATIONAL ELECTRICAL CODE.
- 2. ALL GROUNDING DEVICES SHALL BE U.L. APPROVED OR LISTED FOR THEIR INTENDED
- 3. ALL WIRES SHALL BE AWG THHN/THWN COPPER UNLESS NOTED OTHERWISE.
- 4. GROUNDING CONNECTIONS TO GROUND RODS, GROUND RING WIRE, TOWER BASE AND FENCE POSTS SHALL BE EXCTHERMIC ("CADWELDS") UNLESS NOTED OTHERMISE. CLEAN SURFACES TO SHINY METAL. WHERE GROUND WIRES ARE CADWELDED TO GALVANIZED SURFACES, SPRAY CADWELD WITH GALVANIZING PAINT.
- GROUNDING CONNECTIONS TO GROUND BARS ARE TO BE TWO-HOLE BRASS MECHANICAL CONNECTORS WITH STAINLESS STEEL HARDWARE (INCLUDING SCREW SET) CLEAN GROUND BAR TO SHINY METAL. AFTER MECHANICAL CONNECTION, TREAT WITH PROTECTIVE ANTIOXIDANT COATING.
- 6. GROUND COAXIAL CABLE SHIELDS AT BOTH ENDS WITH MANUFACTURER'S GROUNDING KITS.
- ROUTE GROUNDING CONDUCTORS THE SHORTEST AND STRAIGHTEST PATH POSSIBLE. BEND GROUNDING LEADS WITH A MINIMUM 12" RADIUS.

- 10. THE GROUND ELECTRODE SYSTEM SHALL CONSIST OF DRIVEN GROUND RODS POSITION ACCORDING TO GROUNDING PLAN. THE GROUND RODS SHALL BE 5/8"X10"-0" COPPER CLAD STEEL INTERCONNECTED WITH #2 BARE TINNED COPPER WIRE BURIED 36" BELOW GRADE. BURY GROUND RODS A MAXIMUM OF 15' APART, AND A MINIMUM OF 8' APART.
- IF ROCK IS ENCOUNTERED GROUND RODS SHALL BE PLACED AT AN OBLIQUE ANGLE NOT TO EXCEED 45'.
- EXOTHERMIC WELDS SHALL BE MADE IN ACCORDANCE WITH ERICO PRODUCTS BULLETIN A-AT.
- 13. CONSTRUCTION OF GROUND RING AND CONNECTIONS TO EXISTING GROUND RING SYSTEM SHALL BE DOCUMENTED WITH PHOTOGRAPHS PRIOR TO BACKFILLING SITE. PROVIDE PHOTOS TO THE CONSTRUCTION MANAGER.
- 14. ALL GROUND LEADS EXCEPT THOSE TO THE EQUIPMENT ARE TO BE #2 BARE TINNED COPPER WIRE, ALL EXTERIOR GROUND BARS TINNED COPPER.
- 15. PRIOR TO INSTALLING LUGS ON GROUND WIRES, APPLY THOMAS & BETTS KOPR-SHIELD (TM OF JET LUBE INC.). PRIOR TO BOLTING GROUND WIRE LUGS TO GROUND BARS, APPLY KOPR-SHIELD OR EQUAL
- 16. ENGAGE AN INDEPENDENT ELECTRICAL TESTING FIRM TO TEST AND VERIFY THAT IMPEDANCE DOES NOT EXCEED FIVE OHMS TO GROUND BY MEANS OF "FALL OF POTENTIAL TEST". TEST SHALL BE WITHESSED BY A REPRESENTATIVE, AND RECORDED ON THE "GROUND RESISTANCE TEST" FORM.
- 17. WHERE BARE COPPER GROUND WIRES ARE ROUTED FROM ANY CONNECTION ABOVE GRADE TO GROUND RING, INSTALL WIRE IN 3/4" PVC SLEEVE, FROM 1' BELOW GRADE AND SEAL TOP WITH SILICONE MATERIAL.
- 18. PREPARE ALL BONDING SURFACES FOR GROUNDING CONNECTIONS BY REMOVING ALL PAINT AND CORROSION DOWN TO SHINY METAL. FOLLOWING CONNECTION, APPLY APPROPRIATE ANTI-OXIDIZATION PAINT
- 19. ANY SITE WHERE THE EQUIPMENT (BTS, CABLE BRIDGE, PPC, GENERATOR, ETC.) IS LOCATED WITHIN 6 FEET OF METAL FENCING, THE GROUND RING SHALL BE BONDED TO THE NEAREST FENCE POST USING (3) RUNS OF #2 BARE TINNED COPPER WITH

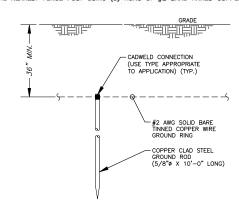

TYPICAL GROUND ROD DETAIL N.T.S.





TYPE GR





TYPE XA



TYPE GL LUG

CADWELD GROUNDING CONNECTION DETAILS

N.T.S.

HEAT SHRINK (CLEAR) -S/S BELLEVILLE WASHER | **| --**1/8" MIN. | 1" || ____1/4" MIN. LARFI


─HEAT SHRINK (CLEAR

(1 OF 2)

- ALL HARDWARE 18-8 STAINLESS STEEL INCLUDING BELLEVILLES. COAT ALL SURFACES WITH ANTI-OXIDATION COMPOUND BEFORE MATING.
- 2. FOR GROUND ROD TO STEEL ONLY: INSERT A DRAGON TOOTH WASHER BETWEEN LUG & STEEL, COAT ALL SURFACES WITH ANTI-OXIDATION COMPOUND
- 3. COAT ALL BARRELS WITH ANTI-OXIDATION COMPOUND BEFORE CRIMPING


GENERAL LUG DETAIL

N.T.S.

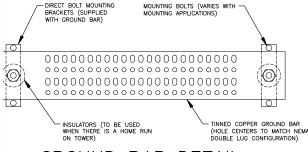

GROUND BAR DETAIL

N.T.S.

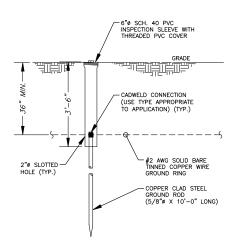

GROUND ROD INSPECTION DETAIL

UP30963A

DESCRIPTION

SUED FOR REVIEW

273 BARKER ROAD

GROUNDING PLAN

MOHAWK, NY 13047

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& DETAILS

G-1